


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- Legend**
- 120.00 PROPOSED ELEVATION
 - 120.90 EXISTING ELEVATIONS
 - OVERLAND FLOW
 - EXISTING OVERLAND FLOW
 - SANITARY MANHOLE
 - STORM MANHOLE
 - CATCH BASIN
 - DOUBLE CATCH BASIN
 - CATCH BASIN MANHOLE
 - AREA DRAIN
 - DOUBLE AREA DRAIN
 - VALVE AND VALVE BOX
 - ◆ HYDRANT AND VALVE
 - ===== CONCRETE CURB
 - DROPPED CURB
 - PROPERTY BOUNDARY
 - WATERMAIN
 - STORM SEWER
 - SANITARY SEWER

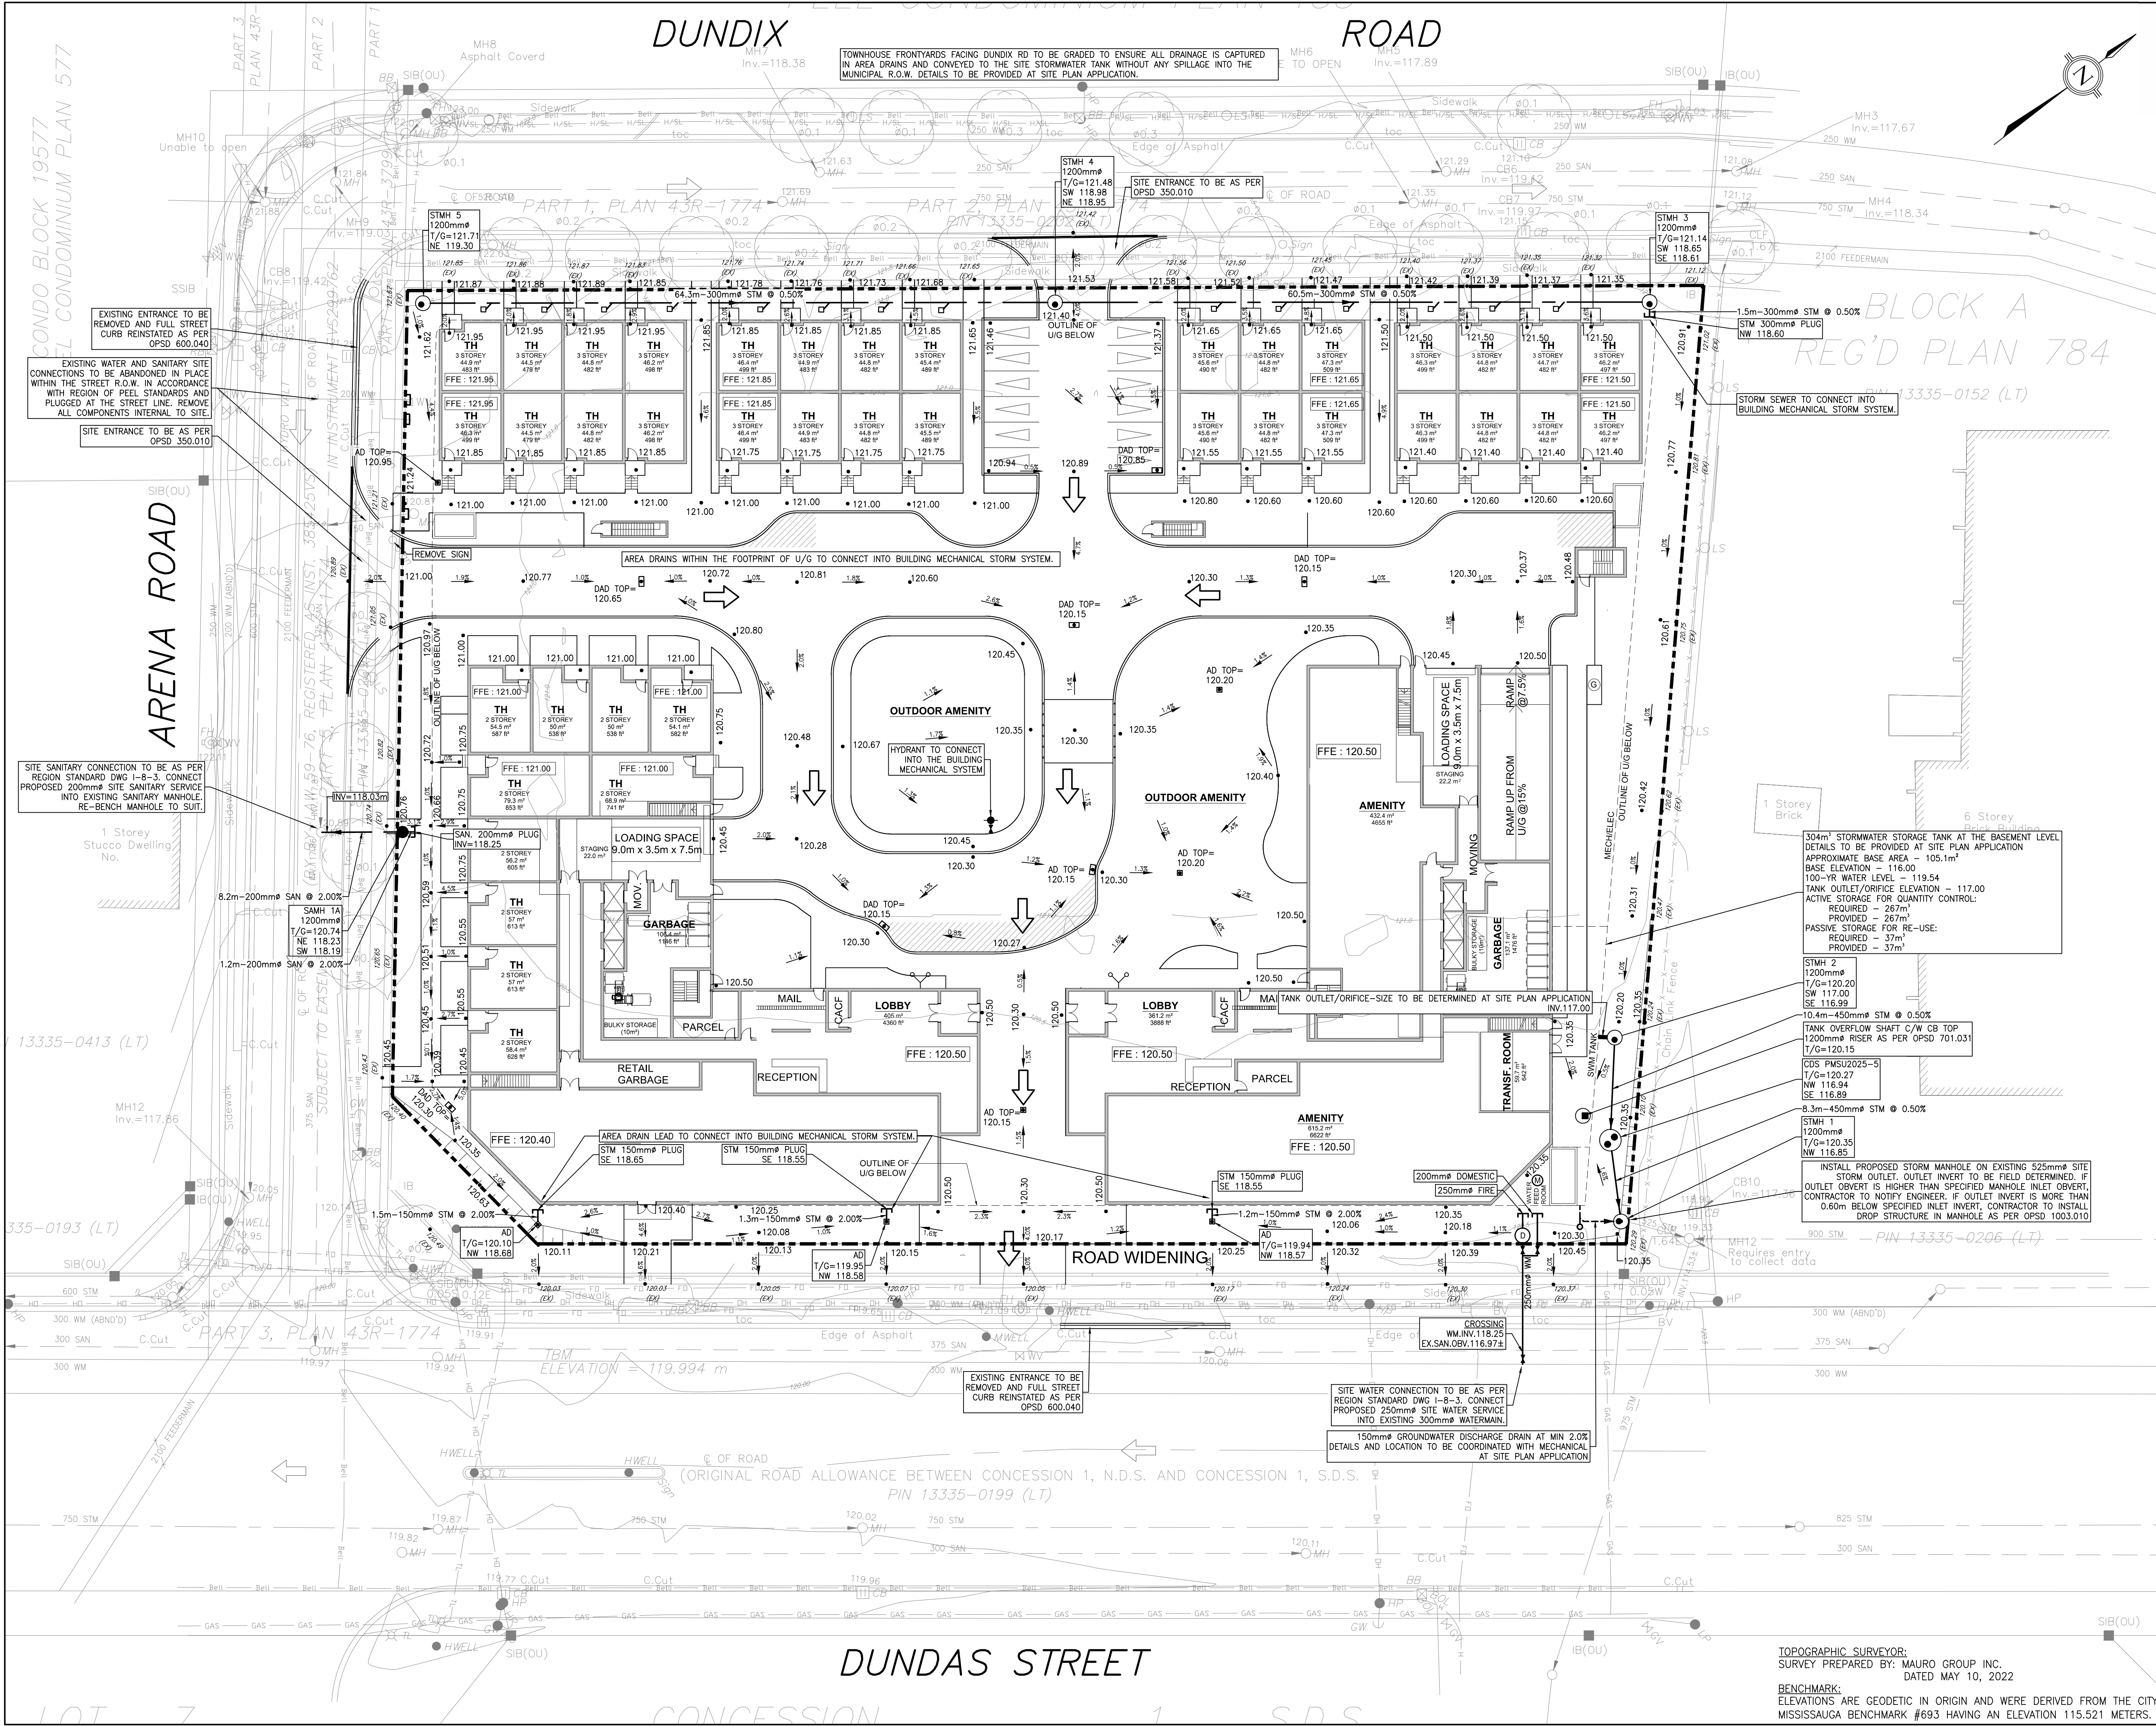

304m³ STORMWATER STORAGE TANK AT THE BASEMENT LEVEL
 DETAILS TO BE PROVIDED AT SITE PLAN APPLICATION
 APPROXIMATE BASE AREA - 105.1m²
 100-YR WATER LEVEL - 119.54
 TANK OUTLET/ORIFICE ELEVATION - 117.00
 ACTIVE STORAGE FOR QUANTITY CONTROL:
 REQUIRED - 267m³
 PROVIDED - 267m³
 PASSIVE STORAGE FOR RE-USE:
 REQUIRED - 37m³
 PROVIDED - 37m³

ISSUED FOR I&A/O&P	PF	AL	24.08.02
ISSUED FOR I&A/O&P&A	PF	AL	22.07.08
Issued	By	Appd.	YYMMDD
File Name:	PF	BC	PF
	Dwn.	Chkd.	Dgn.

Permit-Seal

Client/Project
DUNDIX REALTY HOLDINGS
 c/o SmartCentres REIT.
 PROPOSED RESIDENTIAL DEVELOPMENT
 1225 DUNDAS ST E
 Mississauga, Ontario

Title
GRADING AND SERVICING PLAN

Project No. 160623078
 Drawing No. C-101
 Scale 1:300
 Sheet 9 of 15
 Revision

TOPOGRAPHIC SURVEYOR:
 SURVEY PREPARED BY: MAURO GROUP INC.
 DATED MAY 10, 2022
 BENCHMARK:
 ELEVATIONS ARE GEODETIC IN ORIGIN AND WERE DERIVED FROM THE CITY OF MISSISSAUGA BENCHMARK #693 HAVING AN ELEVATION 115.521 METERS.

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 2024/08/01 1:07 PM by: Franck, Pomponin
 ORIGINAL SHEET - ARCH-D